2020 SIDEWALK REPAIRS RIVER OAKS AND FARR ROAD

PROJECT NUMBER: TPI-0100-2020 JANUARY 2, 2020





TOWN OF TYRONE


881 SENOIA ROAD TYRONE, GA 30290 770-487-4038



VICINITY MAP

DRAWING INDEX

| | TITLE SHEET | | | |
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| C100 | DETAILS & SECTION A PLAN VIEW | | | |
| C101 | SECTION B PLAN VIEW | | | |
| C102 | RIVER OAKS PLAN VIEW | | | |

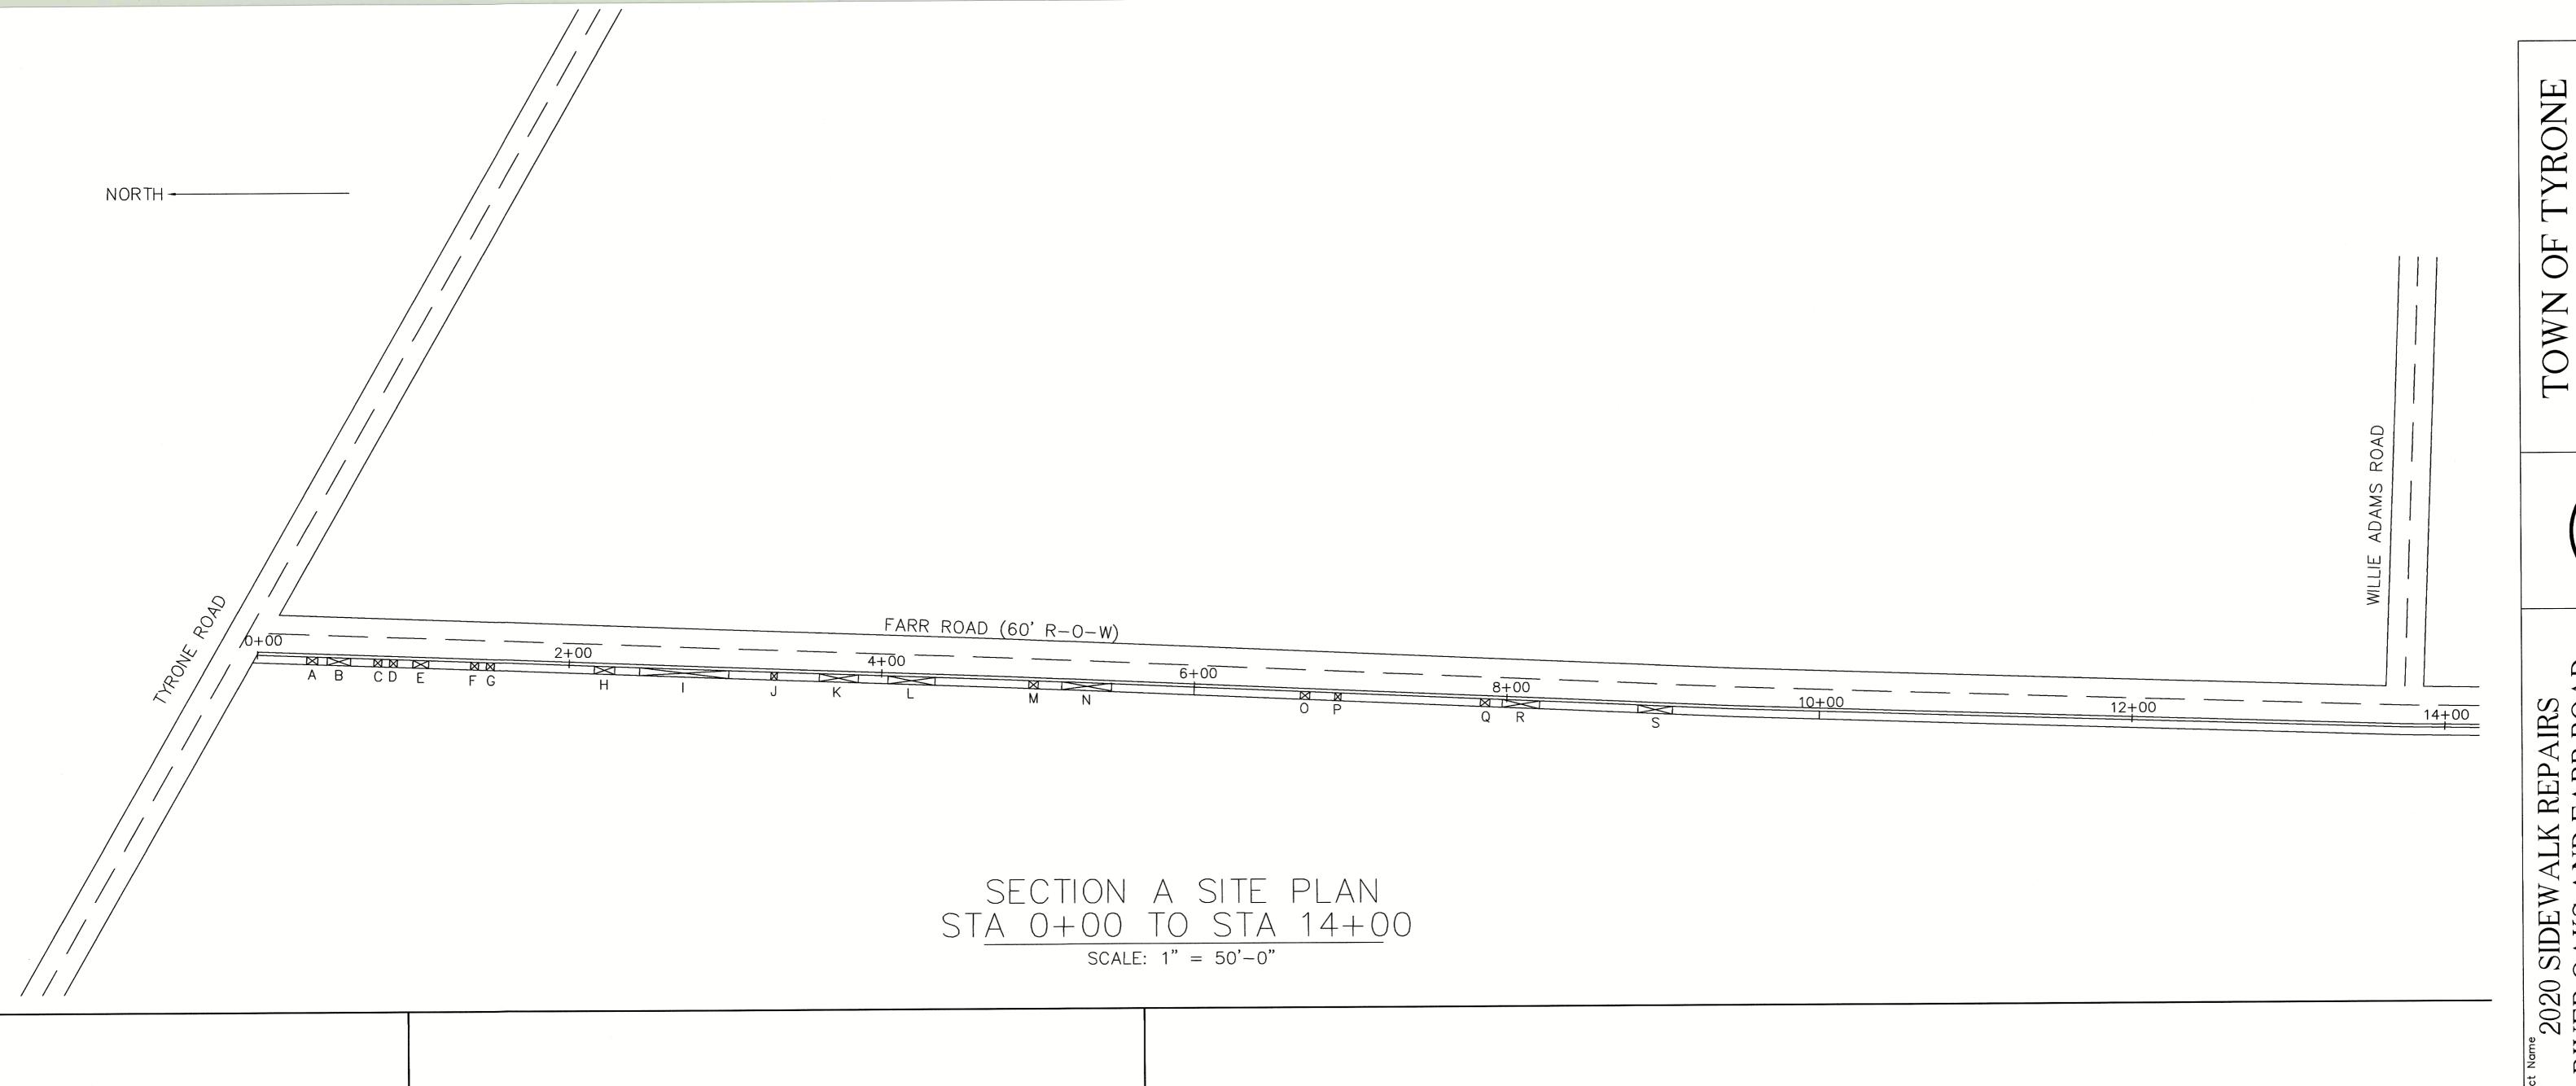

FARR ROAD SIDEWALK SCHEDULE REMOVE & REPLACE SIDEWALK

| | START | END | LINEAR | SQUARE |
|-------------|-------|------|--------|--------|
| AREA | STA | STA | FEET | FEET |
| Α | 0+32 | 0+39 | 7 | 35 |
| В | 0+46 | 0+60 | 14 | 70 |
| B C D 世 F G | 0+76 | 0+80 | 4 | 20 |
| D | 0+96 | 0+90 | 4 | 20 |
| E | 1+05 | 1+10 | 5 | 25 |
| F | 1+37 | 1+42 | 5 | 25 |
| G | 1+47 | 1+53 | 6 | 30 |
| Н | 2+16 | 2+29 | 13 | 65 |
| 1 | 2+45 | 3+02 | 57 | 285 |
| J | 3+29 | 3+33 | 4 | 20 |
| K | 3+60 | 3+86 | 26 | 130 |
| L | 4+04 | 4+35 | 31 | 155 |
| М | 4+95 | 5+00 | 5 | 25 |
| N | 5+15 | 5+47 | 32 | 160 |
| 0 | 6+68 | 6+74 | 6 | 30 |
| 0 P | 6+90 | 6+94 | 4 | 20 |
| Q | 7+83 | 7+89 | 6 | 30 |
| Q R | 7+97 | 8+21 | 24 | 120 |
| S | 8+70 | 8+92 | 22 | 110 |
| TOTAL | | | 275 | 1375 |

BEFORE DIGGING IN GEORGIA

CALL 811

PROJECT GENERAL NOTES:

1) SIDEWALK WILL BE MARKED IN THE FIELD AT PRECON WITH CONTRACTOR AND THE TOWN OF

TYRONE (OWNER).

2) CONTRACTOR IS RESPONSIBLE FOR UTILITY LOCATES AND MARKING BEFORE CONSTRUCTION. ANY DAMAGE TO UTILITIES WILL BE REPAIRED TO THE UTILITY COMPANY'S ACCEPTANCE AND PAID BY THE CONTRACTOR. ALL REPAIRS WILL BE AT NO COST TO THE OWNER.

3) INSPECTION ARE REQUIRED PRIOR TO CONCRETE POUR. CONTRACTOR WILL CONTACT OWNER 48 HOURS PRIOR TO POUR FOR INSPECTION. OWNER WILL PAY FOR ONE INSPECTION FOR EACH POUR AND ANY RE-INSPECTIONS OR DELAYS WILL BE AT THE COST OF THE CONTRACTOR.
4) CONTRACTOR IS RESPONSIBLE FOR ALL TRAFFIC CONTROL. TRAFFIC CONTROL SHALL MEET MUTCD

AND GDOT REQUIREMENTS.
5) CONTRACTOR SHALL PROVIDE WARNING SIGNAGE AND BARRIERS AROUND OPEN EXCAVATIONS AND WORK AREAS.

6) PLANS ARE A GENERAL REPRESENTATION OF LOCATION AND DIMENSIONS. CONTRACTOR IS REQUIRED TO PERFORM A SITE VISIT PRIOR TO BID TO FIELD VERIFY ALL ONSITE CONDITIONS AND MEASUREMENTS. NO ADJUSTMENTS WILL BE MADE IN COST FOR ANY ITEM THAT COULD/SHOULD HAVE

BEEN IDENTIFIED DURING A SITE VISIT.

7) WORK HOURS SHALL BE 8AM TO 6PM. WORK BEYOND THESE HOURS MUST BE APPROVED IN WRITING BY THE OWNER PRIOR TO THE WORK BEING PERFORMED.

8) CONTRACTOR SHALL BE RESPONSIBLE FOR ALL WORK SAFETY AND COMPLIANCE WITH OSHA REGULATIONS. THE CONTRACTOR SHALL NOT PLAY MUSIC OR ALLOW SMOKING ON THE JOB SITE.

9) CONTRACTOR SHALL BE RESPONSIBLE FOR SITE SECURITY. LOCATION OF OVERNIGHT PARKING OF EQUIPMENT AND VEHICLES MUST BE APPROVED BY THE OWNER.

10) COLLECTION OF TRASH/DEBRIS SHALL BE AT THE END OF EACH WORK DAY. ALL TRASH/DEBRIS

SHALL BE DISPOSED OF LEGALLY OFFSITE.

11) CONTRACTOR SHALL INSTALL AND REMOVE EROSION CONTROL MEASURES AS NEEDED AT EACH LOCATION. THIS INCLUDES PROVIDING A CONCRETE WASHOUT AREA/DUMPSTER.

LOCATION. THIS INCLUDES PROVIDING A CONCRETE WASHOUT AREA/DUMPSTER.

12) IN RIVER OAKS SUBDIVISION, CONTRACTOR SHALL REPLACE ALL GRASS AREAS DISTURBED WITH SOD THAT MATCHES THE SPECIES OF THE EXISTING SOD. ANY OTHER LANDSCAPING SHALL BE REPLACED TO MATCH THE PRE—CONSTRUCTION CONDITIONS. (THIS INCLUDES, BUT IS NOT LIMITED TO, MULCH, PINE STRAW, BUSHES, AND IRRIGATION SYSTEM PARTS).

13) ON FARR ROAD, CONTRACTOR SHALL GRASS ALL DISTURBED AREAS WITH COMMON BERMUDA SEED AND STRAW. USE EROSION CONTROL MATTING ON SLOPES STEEPER THAN 1V: 4H.


14) CONTRACTOR IS RESPONSIBLE FOR REMOVAL AND DISPOSAL OF EXISTING CONCRETE SIDEWALK AND PROTECTING EXISTING CONCRETE TO REMAIN. ALL CUTS SHALL BE SAW CUT. ALL CUTS SHALL BE

CONSIDERED AN EXPANSION JOINT AND SHALL HAVE JOINT FILLER PER EXPANSION JOINT DETAIL.

15) NEW SIDEWALK TOOLING AND FINISH SHALL MATCH EXISTING SIDEWALK.

16) CURB REPAIRS SHALL MATCH THE EXISTING CURB DIMENSIONS AND SHAPE. ALL CUTS SHALL BE SAW CUT AT JOINT UNLESS OTHERWISE DEPICTED ON THE DRAWINGS.

17) ALL CONCRETE SIDEWALKS AND CURBS SHALL BE 3000 PSI FIBER REINFORCED CONCRETE WITH 1.5 POUNDS OF FIBER PER CUBIC YARD ADDED AT THE CONCRETE PLANT.

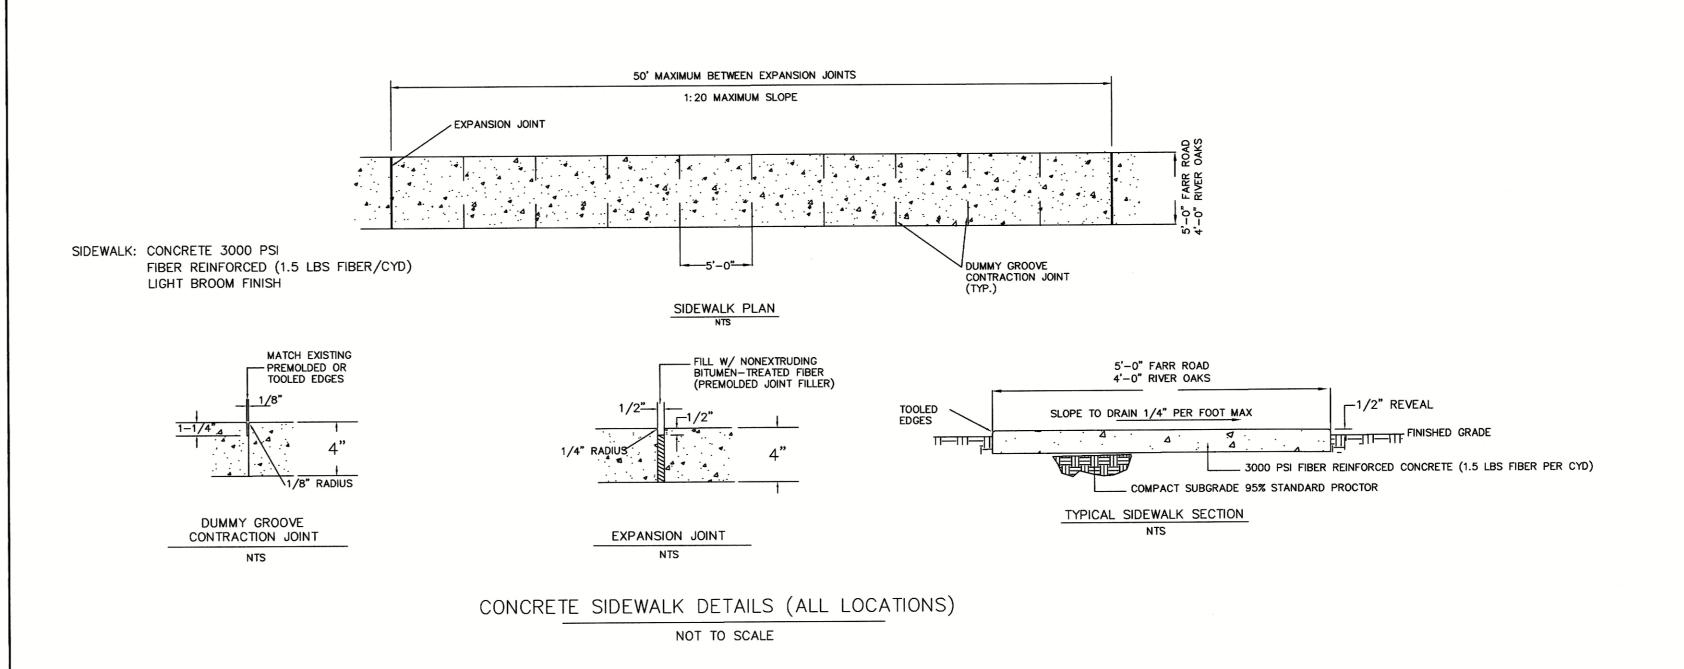

R ROAD

* No. 43699

* No. 43699

* PROFESSIONW

30290

RIVER OAKS AND FARR ROAD oject No.

TPI-0100-2020

TOWN OF TYRONE

SIDE WALK REPAIRS

Summary

Date By

DETAILS &
SECTION A
PLAN VIEW
Sheet Title

Scale AS NOTED


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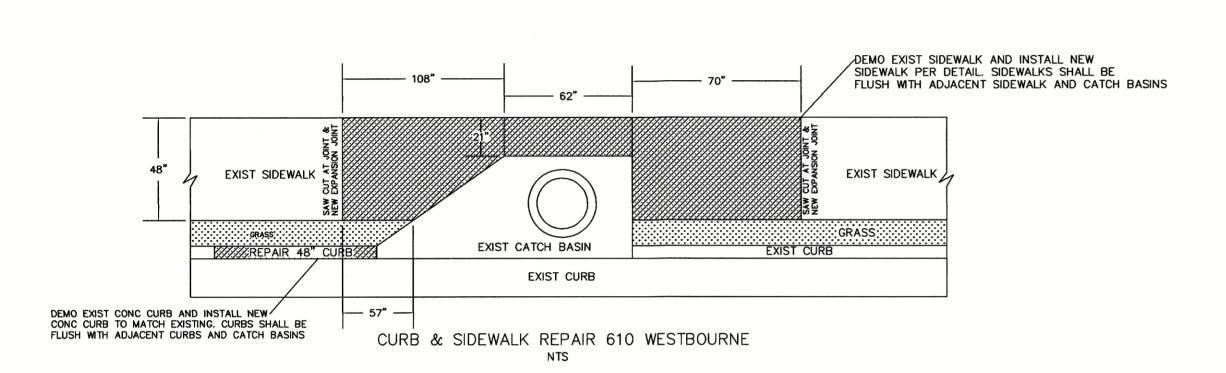
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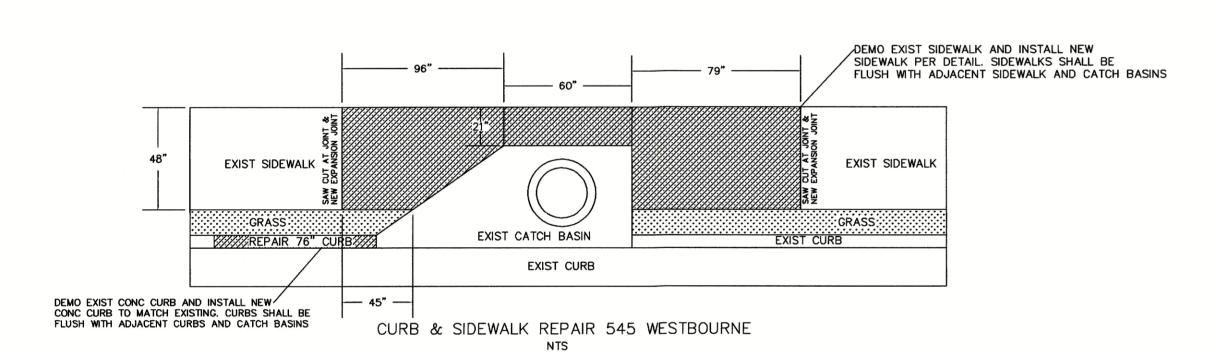
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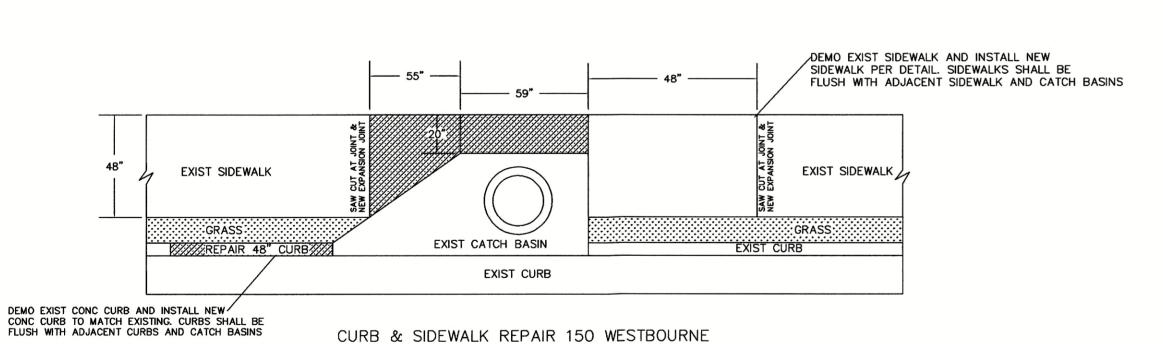
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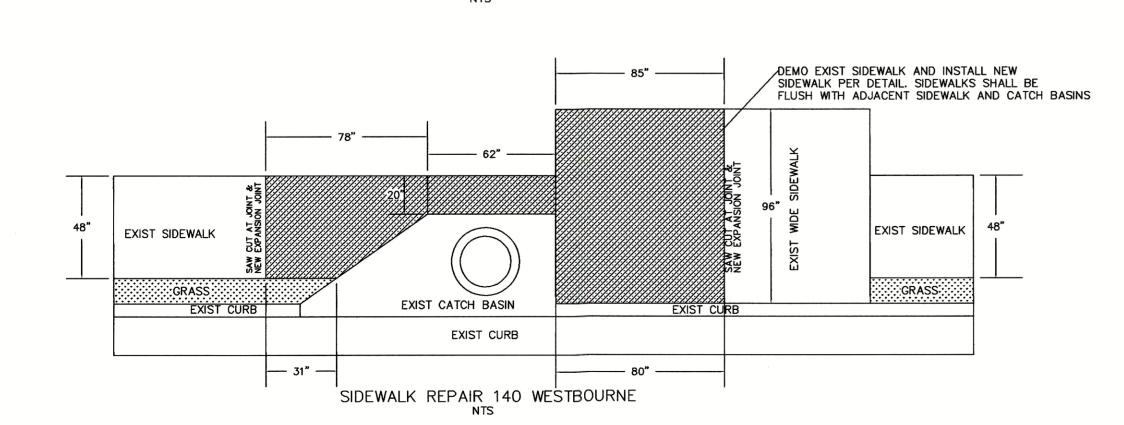
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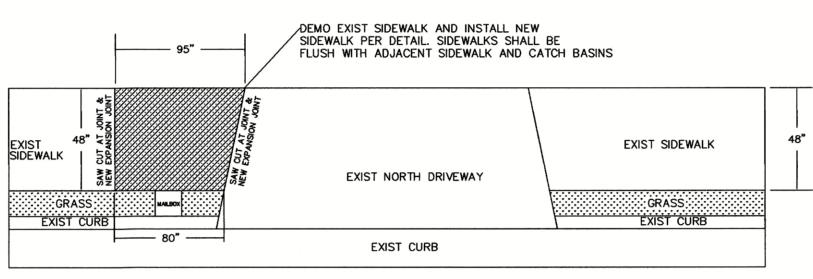












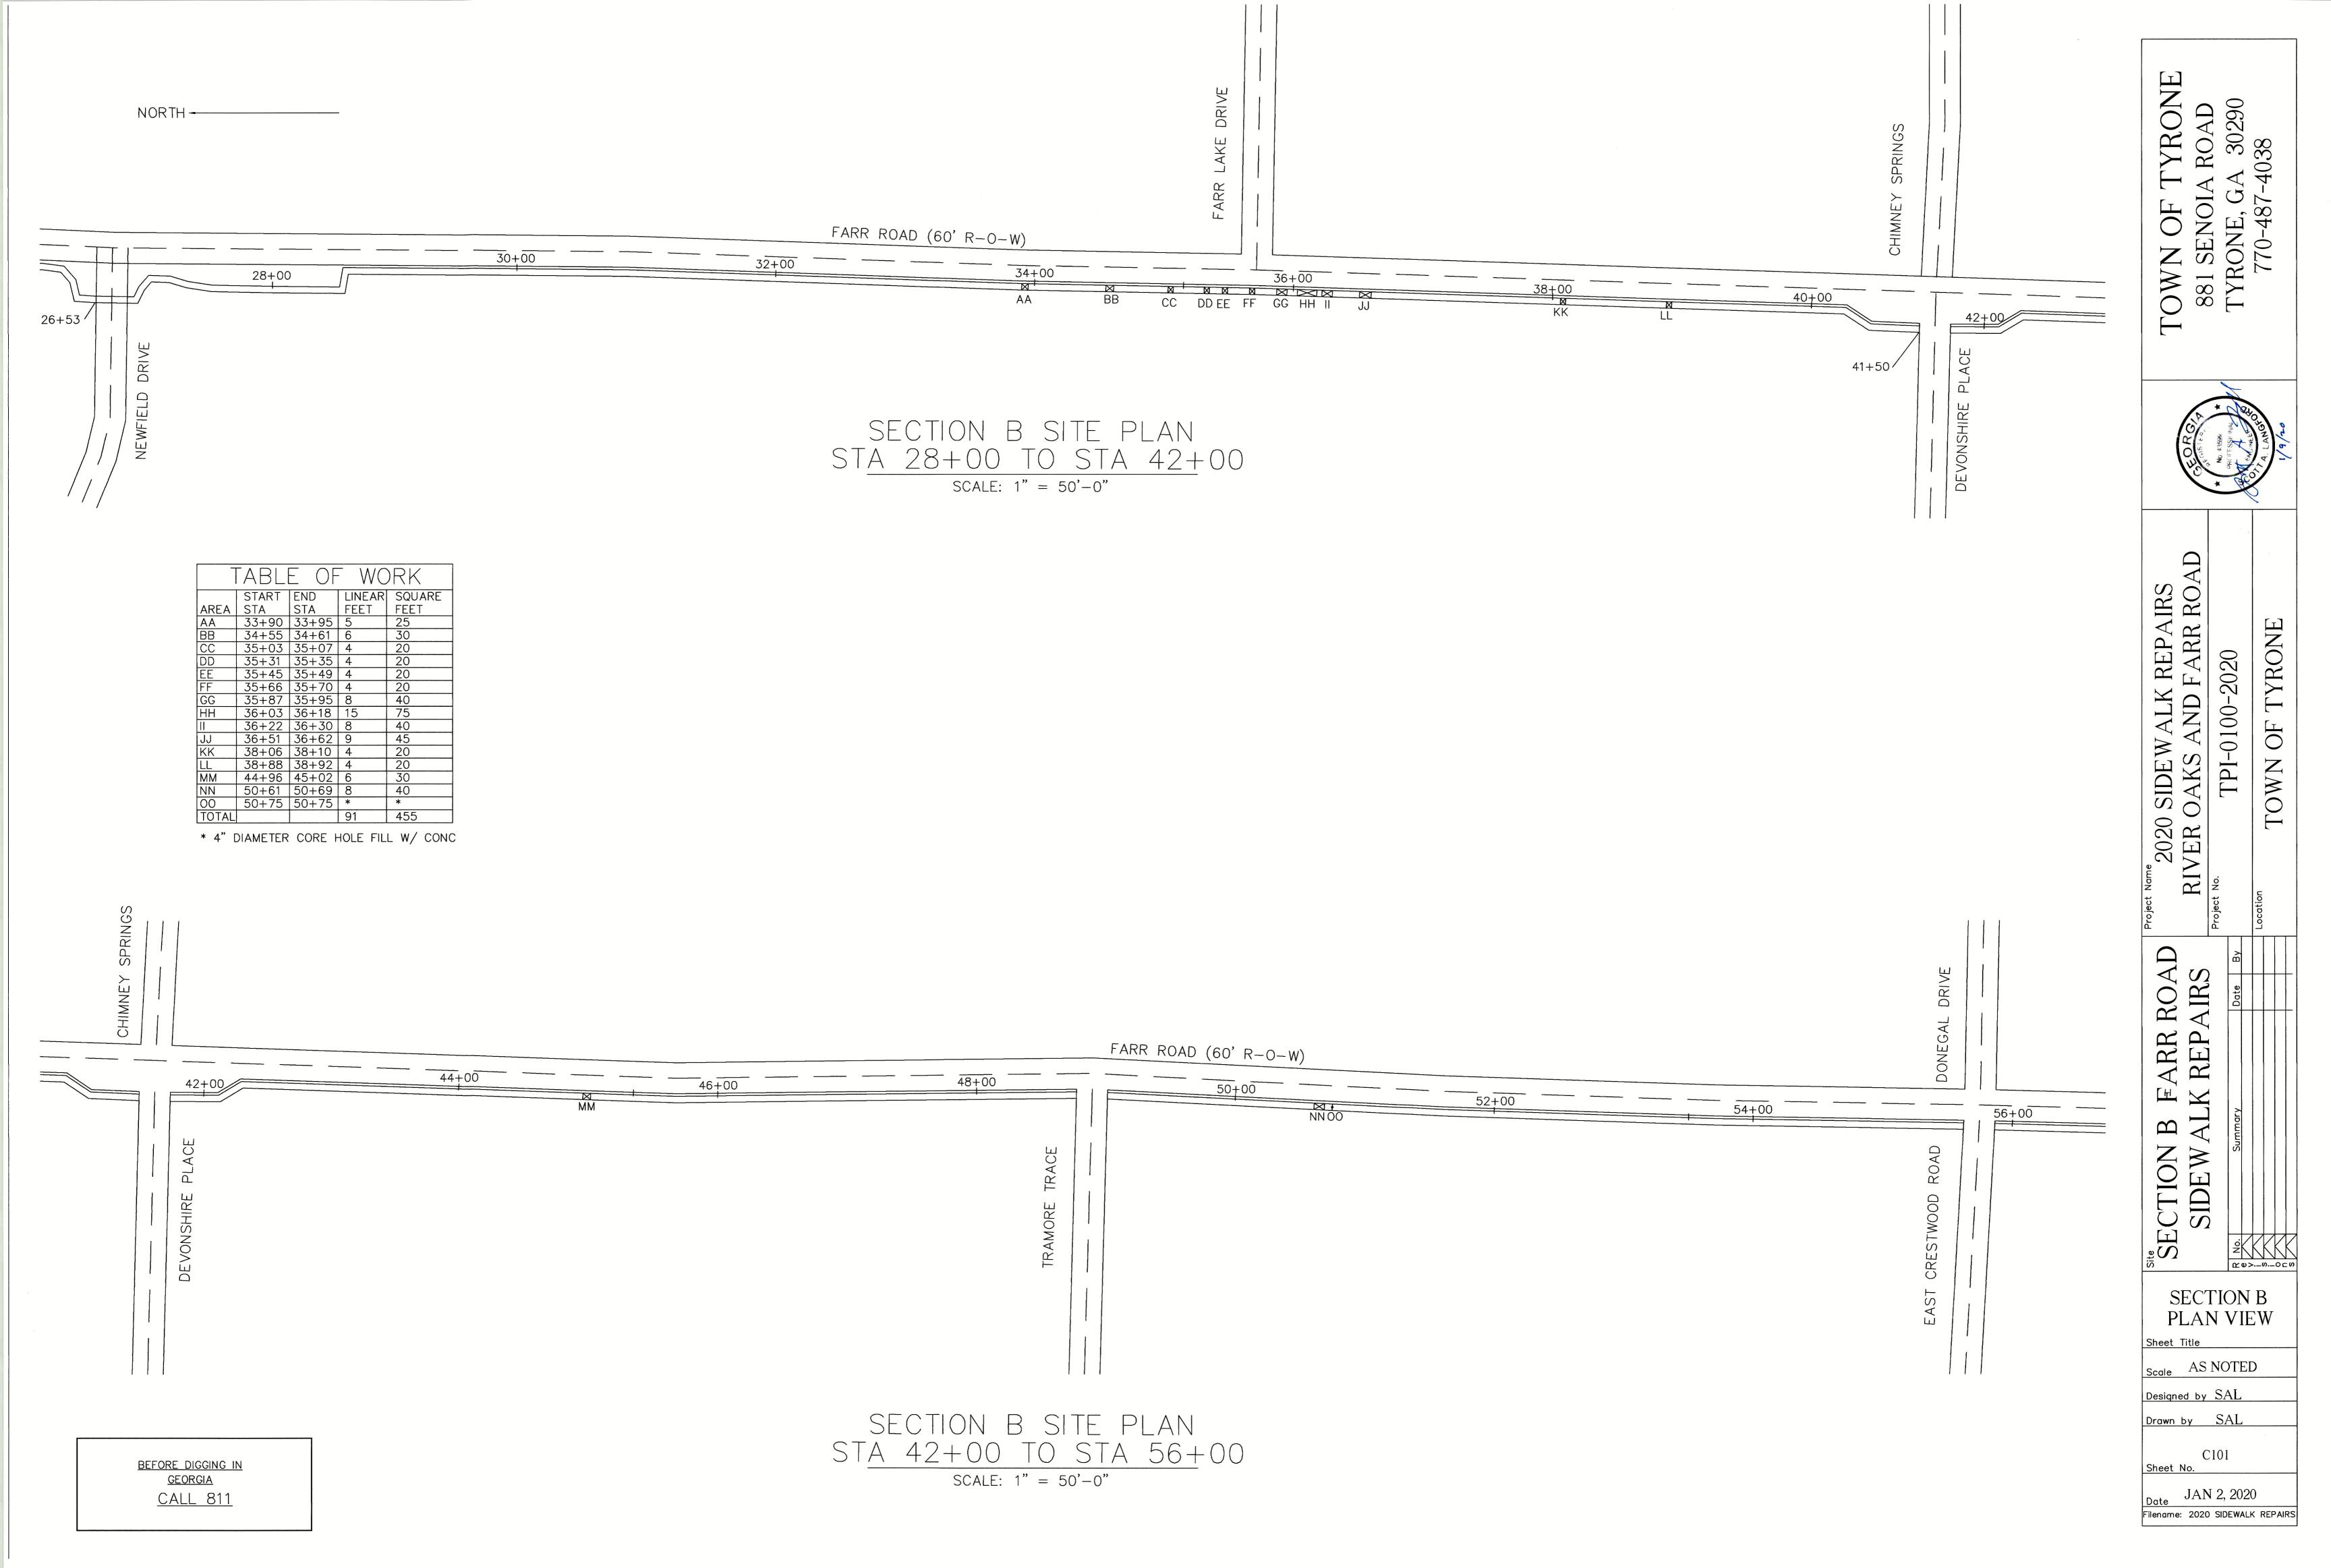



SIDEWALK REPAIR 635 WESTBOURNE

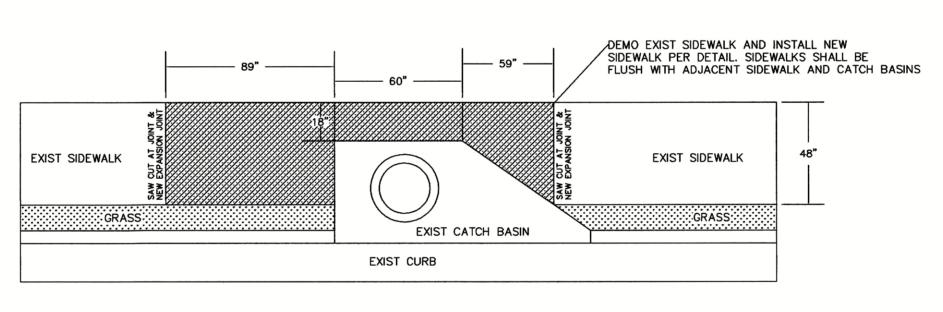


SIDEWALK REPAIR 125 WESTBOURNE

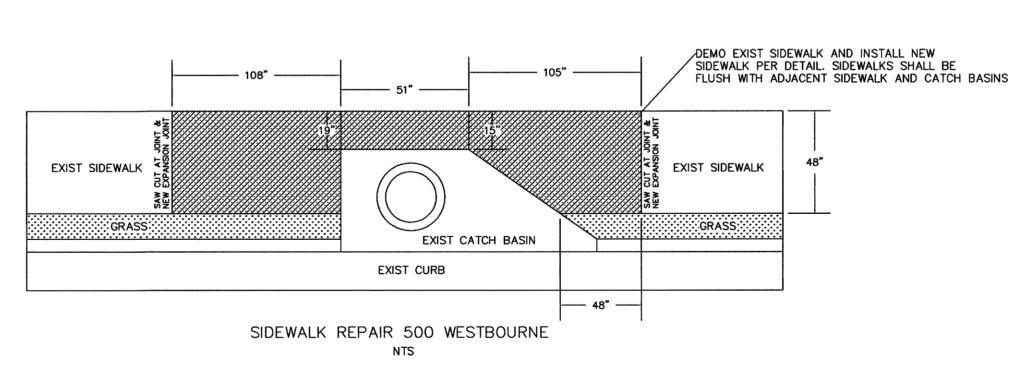

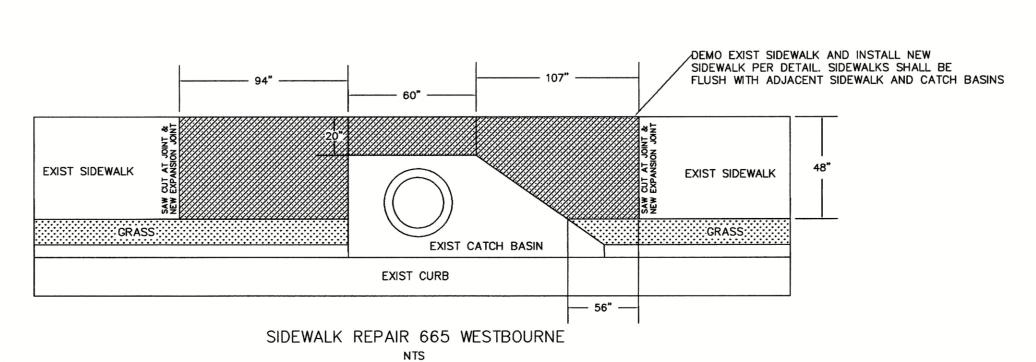


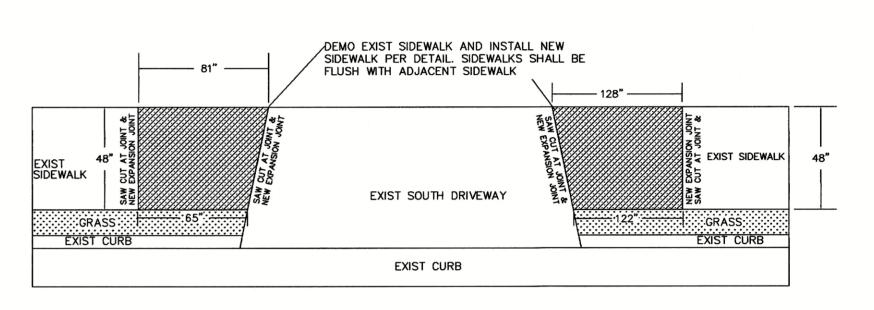


SIDEWALK REPAIR 635 WESTBOURNE

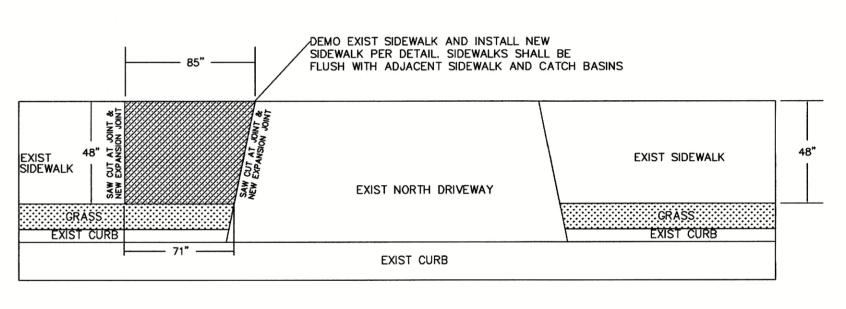

SIDEWALK REPAIR 600 WESTBOURNE

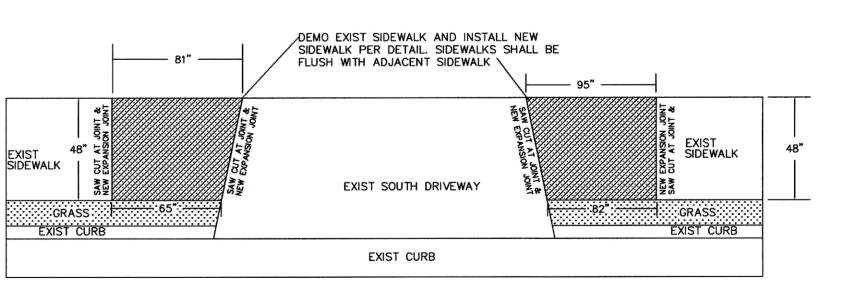

SIDEWALK REPAIR 600 WESTBOURNE

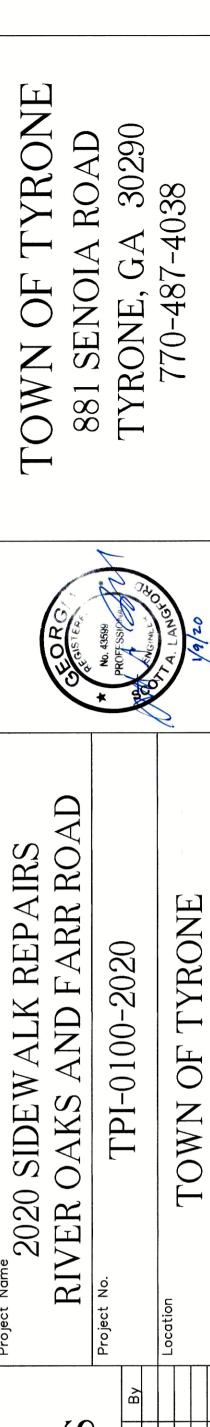

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Date JAN 2, 2020

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